# SITE NAME: WL720/GRAFTON-AT&T

**43 ESTABROOK STREET GRAFTON, MA 01519 WORCESTER COUNTY** 

## T-MOBILE SITE NUMBER: 4WL0720A

**CROWN BU NUMBER: 842903** RF DESIGN GUIDELINE: 702Cu

#### IS STRICTLY PROHIBITED. DUPLICATION AND USE BY GOVERNMENT AGENCIES FOR THE PURPOSES OF CONDUCTING THEIR LAWFULLY AUTHORIZED REGULATORY AND ADMINISTRATIVE FUNCTIONS IS SPECIFICALLY ALLOWED. THE FACILITY IS AN UNMANNED PRIVATE AND SECURED EQUIPMENT INSTALLATION. IT IS ONLY ACCESSED BY TRAINED TECHNICIANS FOR PERIODIC ROUTINE MAINTENANCE AND THEREFORE DOES NOT REQUIRE ANY WATER OR SANITARY SEWER SERVICE. THE FACILITY IS NOT GOVERNED BY REGULATIONS REQUIRING

CONTRACTOR SHALL VERIFY ALL PLANS AND EXISTING DIMENSIONS AND CONDITIONS ON THE JOB SITE AND SHALL IMMEDIATELY NOTIFY THE T-MOBILE NORTHEAST, LLC REPRESENTATIVE IN WRITING OF DISCREPANCIES BEFORE PROCEEDING WITH THE WORK OR BE RESPONSIBLE FOR SAME.

THIS DOCUMENT IS THE CREATION, DESIGN, PROPERTY AND COPYRIGHTED WORK OF T-MOBILE. ANY DUPLICATION OR USE WITHOUT EXPRESS WRITTEN CONSENT

#### SPECIAL STRUCTURAL NOTES

PUBLIC ACCESS PER ADA REQUIREMENTS.

**GENERAL NOTES** 

**APPROVALS** 

PROJECT MANAGER

CONSTRUCTION

RF ENGINEERING

OPERATIONS

TOWER OWNER

ZONING / SITE ACQ.

CONTRACTOR SCOPE OF WORK SHALL INCLUDE ALL REQUIRED STRUCTURAL MODIFICATIONS, RE-BUNDLING OF COAXIAL CABLES OR OTHER SPECIAL MODIFICATIONS AS OUTLINED THEREIN.

STRUCTURAL DESIGNS AND DETAILS FOR ANTENNA MOUNTS AND GLOBAL STRUCTURAL STABILITY ANALYSIS COMPLETED ON BEHALF OF T-MOBILE ARE INCLUSIVE OF THE ENTIRE SUPPORT STRUCTURE, EXISTING ANTENNA MOUNTS AND ALL OTHER ASPECTS OF THE STRUCTURE THAT WILL SUPPORT THE T-MOBILE L700 EQUIPMENT DEPLOYMENT AS DEPICTED HEREIN.

HUDSON DESIGN ASSUMES THAT THE EQUIPMENT IS PROPERLY CONSTRUCTED AND MAINTAINED. ALL STRUCTURAL MEMBERS AND THEIR CONNECTION ARE ASSUMED TO BE IN GOOD CONDITION AND ARE FREE FROM DEFECTS WITH NO DETERIORATION TO ITS MEMBER CAPACITIES

DATE

DATE

DATE

DATE

DATE

DATE



#### 72 HOURS



#### T-MOBILE TECHNICIAN SITE SAFETY NOTES

LOCATION	SPECIAL RESTRICTIONS		
SECTOR A: ANTENNA/TMA/RRH	ACCESS NOT PERMITTED		
SECTOR B: ANTENNA/TMA/RRH	ACCESS NOT PERMITTED		
SECTOR C: ANTENNA/TMA/RRH	ACCESS NOT PERMITTED		
GPS/LMU:	UNRESTRICTED CAUTION: OSHA—APPROVED PORTABLE 10' STEP—LADDER REQUIRED		
RADIO CABINETS:	UNRESTRICTED		
PPC DISCONNECT:	UNRESTRICTED		
MAIN CIRCUIT D/C;	UNRESTRICTED		
NIU/T DEMARC:	UNRESTRICTED		
OTHER/SPECIAL:	NONE		

#### PROJECT SUMMARY

SITE ADDRESS:

SCOPE OF WORK: UNMANNED TELECOMMUNICATIONS FACILITY T-MOBILE **EQUIPMENT MODERNIZATION** ZONING JURISDICTION: BASED ON INFORMATION PROVIDED BY T-MOBILE, THIS TELECOMMUNICATIONS EQUIPMENT DEPLOYMENT IS AN TOWN OF GRAFTON) ELIGIBLE FACILITY UNDER THE TAX RELIEF ACT OF 2012, 47

USC 1455(A), AND IS SUBJECT TO AN EXPEDITED ELIGIBLE FACILITIES REQUEST/REVIEW AND ZONING PRE-EMPTION FOR LOCAL DISCRETIONARY PERMITS (VARIANCE, SPECIAL PERMIT, SITE PLAN REVIEW).

RECEIVED

JAN 1 0 2017

PLANNING BOARD

0

43 ESTABROOK STREET

LATITUDE: 42° 13' 35.33" N LONGITUDE: 71° 39' 51.78" W

JURISDICTION: NATIONAL, STATE & LOCAL CODES OR ORDINANCES

CURRENT USE: TELECOMMUNICATIONS FACILITY PROPOSED USE: TELECOMMUNICATIONS FACILITY CROWN CASTLE INTERNATIONAL

500 W CUMMINGS PARK, SUITE 6500 TOWER OWNER: WOBURN, MA 01801

CROWN SITE ID:

GRAFTON EASTBROOK STREET (MA3193) CROWN SITE NAME:

#### DRAWING INDEX



SHEET

A-3

TITLE SHEET

GN-1 GENERAL NOTES

COMPOUND & EQUIPMENT PLANS

ANTENNA LAYOUTS & ELEVATION A-2

GRAFTON, MA DETAILS

E-1 ONE-LINE DIAGRAM AND GROUNDING DETAILS

#### **T-MOBILE** NORTHEAST LLC

15 COMMERCE WAY SHITE R NORTON, MA 02744 OFFICE: (508) 286-2700 FAX: (508) 286-2893



12 GILL STREET, SUITE 5800



600 OSGOOD STREET UILDING 20 NORTH, SUITE 3090 I. ANDOVER, MA 01845 FAX: (978) 336-558



CHECKED BY: BB

APPROVED BY: DJC

SUBMITTALS

REV.	DATE	DESCRIPTION	BY
0	11/10/16	ISSUED FOR REVIEW	DJM

SITE NUMBER 4WL0720A CROWN CASTLE SITE ID: 842903

WL720/GRAFTON-AT&T

SITE ADDRESS: 43 ESTABROOK STREET GRAFTON, MA 01519 WORCESTER COUNTY

TITLE SHEET

(1.700)SHEET NUMBER

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CALL TOLL FREE 1-888-DIG-SAFE OR CALL 811

**UNDERGROUND SERVICE ALERT** 

#### **GROUNDING NOTES**

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- 1. THE SUBCONTRACTOR SHALL REVIEW AND INSPECT THE EXISTING FACILITY GROUNDING SYSTEM AND LIGHTNING PROTECTION SYSTEM (AS DESIGNED AND INSTALLED) FOR STRICT COMPLIANCE WITH THE NEC (AS ADOPTED BY THE AHJ), THE SITE-SPECIFIC (UL, LPI, OR NFPA) LIGHTING PROTECTION CODE, AND GENERAL COMPLIANCE WITH TELCORDIA AND TIA GROUNDING STANDARDS. THE SUBCONTRACTOR SHALL REPORT ANY VIOLATIONS OR ADVERSE FINDINGS TO THE CONTRACTOR FOR RESOLUTION.
- 2. ALL GROUND ELECTRODE SYSTEMS (INCLUDING TELECOMMUNICATION, RADIO, LIGHTNING PROTECTION, AND AC POWER GES'S) SHALL BE BONDED TOGETHER, AT OR BELOW GRADE, BY TWO OR MORE COPPER BONDING CONDUCTORS IN ACCORDANCE WITH THE NEC.
- 3. THE SUBCONTRACTOR SHALL PERFORM IEEE FALL-OF-POTENTIAL RESISTANCE TO EARTH TESTING (PER IEEE 1100 AND 81) FOR NEW GROUND ELECTRODE SYSTEMS. THE SUBCONTRACTOR SHALL FURNISH AND INSTALL SUPPLEMENTAL GROUND ELECTRODES AS NEEDED TO ACHIEVE A TEST RESULT OF 5 OHMS OR LESS.
- METAL RACEWAY SHALL NOT BE USED AS THE NEC REQUIRED EQUIPMENT GROUND CONDUCTOR. STRANDED COPPER CONDUCTORS WITH GREEN INSULATION, SIZED IN ACCORDANCE WITH THE NEC, SHALL BE FURNISHED AND INSTALLED WITH THE POWER CIRCUITS TO BTS EQUIPMENT.
- EACH BTS CABINET FRAME SHALL BE DIRECTLY CONNECTED TO THE MASTER GROUND BAR WITH GREEN INSULATED SUPPLEMENTAL EQUIPMENT GROUND WIRES, 6 AWG STRANDED COPPER OR LARGER FOR INDOOR BTS 2 AWG STRANDED COPPER FOR OUTDOOR BTS.
- 6. EXOTHERMIC WELDS SHALL BE USED FOR ALL GROUNDING CONNECTIONS BELOW GRADE.
- 7. APPROVED ANTIOXIDANT COATINGS (I.E., CONDUCTIVE GEL OR PASTE) SHALL BE USED ON ALL COMPRESSION AND BOLTED GROUND CONNECTIONS.
- 8. ICE BRIDGE BONDING CONDUCTORS SHALL BE EXOTHERMICALLY BONDED OR BOLTED TO GROUND BAR
- ALUMINUM CONDUCTOR OR COPPER CLAD STEEL CONDUCTOR SHALL NOT BE USED FOR GROUNDING CONNECTIONS.
- 10. MISCELLANEOUS ELECTRICAL AND NON-ELECTRICAL METAL BOXES, FRAMES AND SUPPORTS SHALL BE BONDED TO THE GROUND RING, IN ACCORDANCE WITH THE
- 11. METAL CONDUIT SHALL BE MADE ELECTRICALLY CONTINUOUS WITH LISTED BONDING FITTINGS OR BY BONDING ACROSS THE DISCONTINUITY WITH 6 AWS COPPER WIRE UL APPROVED GROUNDING TYPE CONDUIT CLAMPS.
- 12. ALL NEW STRUCTURES WITH A FOUNDATION AND/OR FOOTING HAVING 20 FT. OR MORE OF 1/2 IN. OR GREATER ELECTRICALLY CONDUCTIVE REINFORCING STEEL MUST HAVE IT BONDED TO THE GROUND RING USING AN EXOTHERMIC WELD CONNECTION USING #2 AWG SOLID BARE TINNED COPPER GROUND WIRE, PER NEC

#### **GENERAL NOTES**

1. FOR THE PURPOSE OF CONSTRUCTION DRAWING, THE FOLLOWING DEFINITIONS SHALL APPLY:

CONTRACTOR - CROWN CASTLE INTERNATIONAL SUBCONTRACTOR - GENERAL CONTRACTOR (CONSTRUCTION) OWNER - T-MOBILE

- 2. PRIOR TO THE SUBMISSION OF BIDS, THE BIDDING SUBCONTRACTOR SHALL VISIT THE CELL SITE TO FAMILIARIZE WITH THE EXISTING CONDITIONS AND TO CONFIRM THAT THE WORK CAN BE ACCOMPLISHED AS SHOWN ON THE CONSTRUCTION ANY DISCREPANCY FOUND SHALL BE BROUGHT TO THE ATTENTION OF
- 3. ALL MATERIALS FURNISHED AND INSTALLED SHALL BE IN STRICT ACCORDANCE WITH ALL APPLICABLE CODES, REGULATIONS, AND ORDINANCES. SUBCONTRACTOR SHALL ISSUE ALL APPROPRIATE NOTICES AND COMPLY WITH ALL LAWS, ORDINANCES, RULES, REGULATIONS, AND LAWFUL ORDERS OF ANY PUBLIC AUTHORITY REGARDING THE PERFORMANCE OF THE WORK. ALL WORK CARRIED OUT SHALL COMPLY WITH ALL APPLICABLE MUNICIPAL AND UTILITY COMPANY SPECIFICATIONS AND LOCAL JURISDICTIONAL CODES, ORDINANCES AND APPLICABLE REGULATIONS
- 4. DRAWINGS PROVIDED HERE ARE NOT TO BE SCALED AND ARE INTENDED TO SHOW OUTLINE ONLY.
- UNLESS NOTED OTHERWISE, THE WORK SHALL INCLUDE FURNISHING MATERIALS, EQUIPMENT, APPURTENANCES, AND LABOR NECESSARY TO COMPLETE ALL INSTALLATIONS AS INDICATED ON THE DRAWINGS.
- 6. "KITTING LIST" SUPPLIED WITH THE BID PACKAGE IDENTIFIES ITEMS THAT WILL BE SUPPLIED BY CONTRACTOR. ITEMS NOT INCLUDED IN THE BILL OF MATERIALS AND KITTING LIST SHALL BE SUPPLIED BY THE SUBCONTRACTOR.
- 7. THE SUBCONTRACTOR SHALL INSTALL ALL EQUIPMENT AND MATERIALS IN ACCORDANCE WITH MANUFACTURER'S RECOMMENDATIONS UNLESS SPECIFICALLY STATED OTHERWISE.
- 8. IF THE SPECIFIED EQUIPMENT CANNOT BE INSTALLED AS SHOWN ON THESE DRAWINGS, THE SUBCONTRACTOR SHALL PROPOSE AN ALTERNATIVE INSTALLATION SPACE FOR APPROVAL BY THE CONTRACTOR.
- 9. SUBCONTRACTOR SHALL DETERMINE ACTUAL ROUTING OF CONDUIT, POWER AND T1 CABLES, GROUNDING CABLES AS SHOWN ON THE POWER, GROUNDING AND TELCO PLAN DRAWING. SUBCONTRACTOR SHALL UTILIZE EXISTING TRAYS AND/OR SHALL ADD NEW TRAYS AS NECESSARY. SUBCONTRACTOR SHALL CONFIRM THE ACTUAL ROUTING WITH THE CONTRACTOR.
- 10. THE SUBCONTRACTOR SHALL PROTECT EXISTING IMPROVEMENTS, PAVEMENTS, CURBS, LANDSCAPING AND STRUCTURES. ANY DAMAGED PART SHALL BE REPAIRED AT SUBCONTRACTOR'S EXPENSE TO THE SATISFACTION OF OWNER.
- 11. SUBCONTRACTOR SHALL LEGALLY AND PROPERLY DISPOSE OF ALL SCRAP MATERIALS SUCH AS COAXIAL CABLES AND OTHER ITEMS REMOVED FROM THE EXISTING FACILITY. ANTENNAS REMOVED SHALL BE RETURNED TO THE OWNER'S DESIGNATED
- 12. SUBCONTRACTOR SHALL LEAVE PREMISES IN CLEAN CONDITION
- 13. ALL CONCRETE REPAIR WORK SHALL BE DONE IN ACCORDANCE WITH AMERICAN CONCRETE INSTITUTE (ACI) 301.

- AND SHALL HAVE 4000 PSI STRENGTH AT 28 DAYS. ALL CONCRETE WORK SHALL BE DONE IN ACCORDANCE WITH ACI 318 CODE REQUIREMENTS.
- ACCORDANCE WITH AISC SPECIFICATIONS, ALL STRUCTURAL STEEL SHALL BE ASTM A36 (Fy = 36 ksi) UNLESS OTHERWISE NOTED. PIPES SHALL BE ASTM A53 TYPE E (Fy = 36 ksi). ALL STEEL EXPOSED TO WEATHER SHALL BE HOT DIPPED GALVANIZED. TOUCHUP ALL SCRATCHES AND OTHER MARKS IN THE FIELD AFTER STEEL IS ERECTED USING A COMPATIBLE ZINC RICH PAINT.
- CONSTRUCTION SERVICES FOR CONSTRUCTION OF T-MOBILE SITES.
- ON THE DRAWINGS MUST BE VERIFIED. SUBCONTRACTOR SHALL NOTIFY THE WITH CONSTRUCTION.
- 18. THE EXISTING CELL SITE IS IN FULL COMMERCIAL OPERATION. ANY CONSTRUCTION WORK BY SUBCONTRACTOR SHALL NOT DISRUPT THE EXISTING NORMAL OPERATION. ANY WORK ON EXISTING EQUIPMENT MUST BE COORDINATED WITH CONTRACTOR. ALSO, WORK SHOULD BE SCHEDULED FOR AN APPROPRIATE MAINTENANCE WINDOW USUALLY IN LOW TRAFFIC PERIODS AFTER MIDNIGHT.
- 19. SINCE THE CELL SITE IS ACTIVE, ALL SAFETY PRECAUTIONS MUST BE TAKEN WHEN WORKING AROUND HIGH LEVELS OF ELECTROMAGNETIC RADIATION. EQUIPMENT SHOULD BE SHUTDOWN PRIOR TO PERFORMING ANY WORK THAT COULD EXPOSE
- 20. APPLICABLE BUILDING CODES: SUBCONTRACTOR'S WORK SHALL COMPLY WITH ALL APPLICABLE NATIONAL, STATE, AND LOCAL CODES AS ADOPTED BY THE LOCAL AUTHORITY HAVING JURISDICTION (AHJ) FOR THE LOCATION. THE EDITION OF THE AHJ ADOPTED CODES AND STANDARDS IN EFFECT ON THE DATE OF CONTRACT AWARD SHALL GOVERN THE DESIGN.

BUILDING CODE: MA STATE BUILDING CODE 780 CMR 8TH EDITION ELECTRICAL CODE: REFER TO ELECTRICAL DRAWINGS LIGHTENING CODE: REFER TO ELECTRICAL DRAWINGS

SUBCONTRACTOR'S WORK SHALL COMPLY WITH THE LATEST EDITION OF THE FOLLOWING STANDARDS:

AMERICAN CONCRETE INSTITUTE (ACI) 318; BUILDING CODE REQUIREMENTS FOR STRUCTURAL CONCRETE;

AMERICAN INSTITUTE OF STEEL CONSTRUCTION (AISC)


MANUAL OF STEEL CONSTRUCTION, ASD, FOURTEENTH EDITION:

TELECOMMUNICATIONS INDUSTRY ASSOCIATION (TIA) 222-G. STRUCTURAL STANDARDS FOR STEEL


EQUIPMENT AND ANTENNA SUPPORTING STRUCTURES: REFER TO FLECTRICAL DRAWINGS FOR SPECIFIC ELECTRICAL STANDARDS

FOR ANY CONFLICTS BETWEEN SECTIONS OF LISTED CODES AND STANDARDS REGARDING MATERIAL, METHODS OF CONSTRUCTION, OR OTHER REQUIREMENTS, THE MOST RESTRICTIVE REQUIREMENT SHALL GOVERN. WHERE THERE IS CONFLICT BETWEEN A GENERAL REQUIREMENT AND A SPECIFIC REQUIREMENT, THE SPECIFIC REQUIREMENT SHALL GOVERN.

## 14. ANY NEW CONCRETE NEEDED FOR THE CONSTRUCTION SHALL BE AIR-ENTRAINED

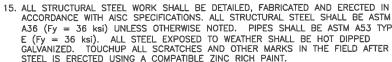



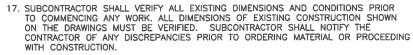

THE WORKERS TO DANGER. PERSONAL RF EXPOSURE MONITORS ARE ADVISED TO BE WORN TO ALERT OF ANY DANGEROUS EXPOSURE LEVELS.

OF MAG DEREK **CREASER** STERED,

CHECKED BY:

DJC APPROVED BY:

**T-MOBILE** NORTHEAST LLC 15 COMMERCE WAY, SUITE B

NORTON, MA 02766

OFFICE: (508) 286-2700

CROWN CASTLE

12 GILL STREET, SUITE 5800 WOBURN, MA 01801

BUILDING 20 NORTH, SUITE 3090 TEL: (978) 557-5553 N. ANDOVER, MA 01845 FAX: (978) 336-5580

**Hudson** 

Design Groupic

ON OSCOOD STREET

**CROWN** 

CASTLE

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SITE NUMBER 4WL0720A CROWN CASTLE SITE ID: 842903 SITE NAME:

WL720/GRAFTON-AT&T

SITE ADDRESS: 43 ESTABROOK STREET GRAFTON, MA 01519 WORCESTER COUNTY

SHEET TITLE

GENERAL NOTES

(L700)


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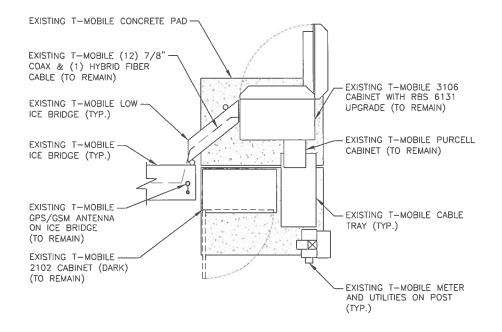
GN-1


			ABBREVIATIONS		
AGL	ABOVE GRADE LEVEL	EQ	EQUAL	REQ	REQUIRED
AWG	AMERICAN WIRE GAUGE	GC	GENERAL CONTRACTOR	RF	RADIO FREQUENCY
BBU	BATTERY BACKUP UNIT	GRC	GALVANIZED RIGID CONDUIT	TBD	TO BE DETERMINED
BTCW	BARE TINNED SOLID COPPER WIRE	MGB	MASTER GROUND BAR	TBR	TO BE REMOVED
BGR	BURIED GROUND RING	MIN	MINIMUM	TBRR	TO BE REMOVED AND REPLACED
BTS	BASE TRANSCEIVER STATION	Р	PROPOSED	TYP	TYPICAL
E	EXISTING	NTS	NOT TO SCALE	UG	UNDER GROUND
EGB	EQUIPMENT GROUND BAR	RAD	RADIATION CENTER LINE (ANTENNA)	VIF	VERIFY IN FIELD
EGR	EQUIPMENT GROUND RING	REF	REFERENCE		


STRUCTURAL NOTES:
PRIOR TO COMMENCING CONSTRUCTION, GC SHALL
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CROWN CASTLE, DATED OCTOBER 30, 2016 TO DETERMINE IF THERE ANY SUPPLEMENTAL OR SPECIAL INSTALLATION REQUIREMENTS, OR RELOCATION ARRANGEMENTS.

NOTE: REFER TO FINAL RF DATA SHEET FOR FINAL ANTENNA SETTINGS



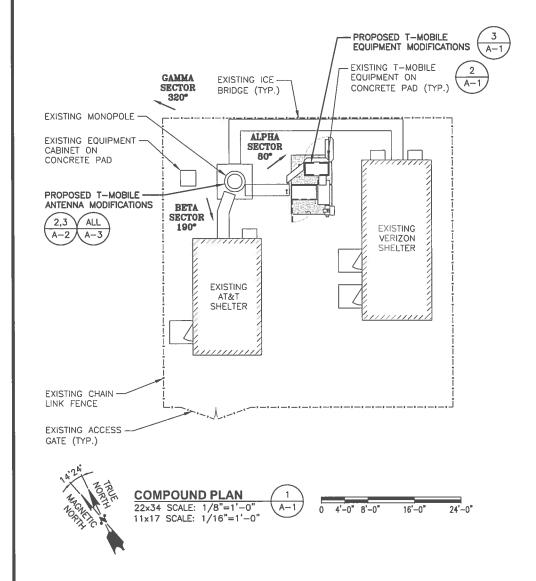

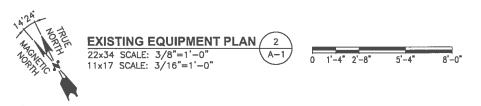

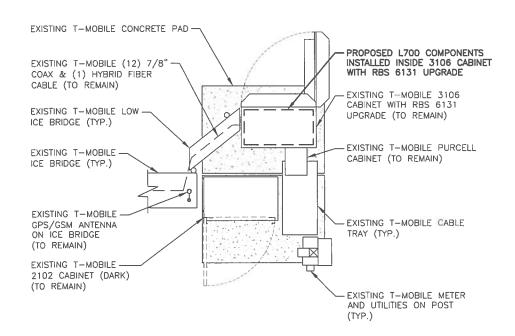



#### T-MOBILE **NORTHEAST LLC**


15 COMMERCE WAY, SUITE B NORTON, MA 02766 OFFICE: (508) 286-2700 FAX: (508) 286-2893



CROWN CASTLE 12 GILL STREET, SUITE 5800



1600 OSGOOD STREET BUILDING 20 NORTH, SUITE 3090 N. ANDOVER, MA 01845 FAX: [978] 336-5586

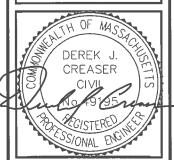

CHECKED BY:

APPROVED BY:

SUBMITTALS

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DJC

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4WL0720A CROWN CASTLE SITE ID: 842903

WL720/GRAFTON-AT&T

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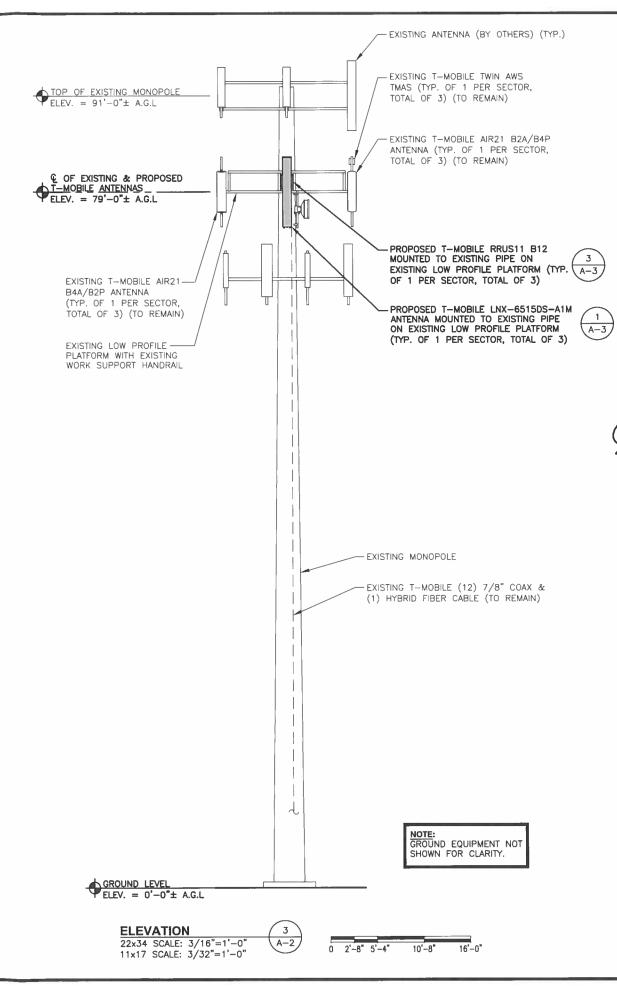
SHEET TITLE

COMPOUND & EQUIPMENT PLAN (L700)

SHEET NUMBER

**A-**1

NOTE: REFER TO FINAL RF DATA SHEET FOR FINAL ANTENNA SETTINGS STRUCTURAL NOTES: PRIOR TO COMMENCING CONSTRUCTION, GC SHAL REFER TO STRUCTURAL ANALYSIS PROVIDED BY CROWN CASTLE, DATED OCTOBER 30, 2016 TO DETERMINE IF THERE ANY SUPPLEMENTAL OR SPECIAL INSTALLATION REQUIREMENTS, OR RELOCATION ARRANGEMENTS. EXISTING T-MOBILE AIR21 B2A/B4P ANTENNA (TYP. OF 1 PER SECTOR, TOTAL OF 3) (TO REMAIN) EXISTING T-MOBILE TWIN AWS TMAS (TYP. OF 1 PER SECTOR, TOTAL OF 3) (TO REMAIN) EXISTING T-MOBILE LOW PROFILE -PLATFORM (TO REMAIN) EXISTING MONOPOLE -ALPHA SECTOR EXISTING WORK SUPPORT HANDRAIL (TYP.) GAMMA SECTOR 320° EXISTING T-MOBILE AIR21 B4A/B2P ANTENNA (TYP. OF 1 PER SECTOR, TOTAL OF 3) (TO REMAIN) BETA SECTOR **EXISTING ANTENNA PLAN** SCALE: N.T.S EXISTING T-MOBILE AIR21 B2A/B4P ANTENNA (TYP. OF 1 PER SECTOR, TOTAL OF 3) (TO REMAIN) EXISTING T-MOBILE TWIN AWS TMAS (TYP. OF 1 PER SECTOR, TOTAL OF 3) ALPHA (TO REMAIN) SECTOR EXISTING T-MOBILE LOW PROFILE -PLATFORM (TO REMAIN) PROPOSED T-MOBILE LNX-6515DS-A1M ANTENNA MOUNTED TO EXISTING PIPE ON EXISTING LOW PROFILE PLATFORM EXISTING MONOPOLE -A-3 (TYP. OF 1 PER SECTOR, TOTAL OF 3) EXISTING WORK SUPPORT HANDRAIL (TYP.) PROPOSED T-MOBILE RRUS11 B12 MOUNTED TO EXISTING PIPE ON GAMMA EXISTING LOW PROFILE PLATFORM (TYP. (A-3) SECTOR OF 1 PER SECTOR, TOTAL OF 3) EXISTING T-MOBILE AIR21 B4A/B2P ANTENNA (TYP. OF 1 PER SECTOR, TOTAL OF 3) (TO REMAIN) BETA SECTOR PROPOSED ANTENNA PLAN 2



#### **T-MOBILE NORTHEAST LLC**

15 COMMERCE WAY, SUITE B NORTON, MA 02766 OFFICE: (508) 286-2700 FAX: (508) 286-2893



CROWN CASTLE 12 GILL STREET, SUITE 5800 WOBURN, MA 01801



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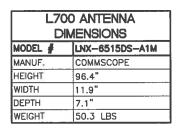
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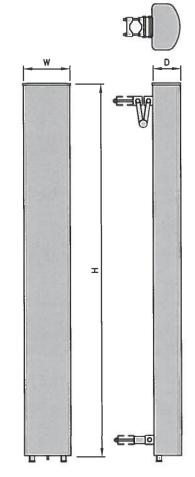
ANTENNA LAYOUT & ELEVATION (L700)

SHEET NUMBER


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NOTE: REFER TO FINAL RF DATA SHEET FOR FINAL ANTENNA SETTINGS





L700 ANTENNA DETAIL SCALE: N.T.S

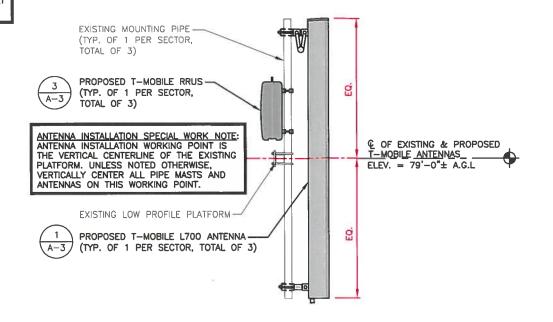

EXISTING LOW PROFILE PLATFORM -

(TO REMAIN)

EXISTING T-MOBILE AIR21 B4A/B2P-ANTENNA (TYP. OF 1 PER SECTOR,

TOTAL OF 3) (TO REMAIN)

**L700 ANTENNA MOUNTING DETAIL** 22x34 SCALE: 3/4"=1'-0" 11x17 SCALE: 3/8"=1'-0"



RRU DIMENSIONS MODEL # RRUS11 B12 MANUF. ERICSSON WIDTH DEPTH HEIGHT 20" WEIGHT 50.6 LBS



SIDE

PROPOSED RRU DETAIL SCALE: N.T.S

PROPOSED T-MOBILE LNX-6515DS-A1M ANTENNA MOUNTED TO EXISTING PIPE ON EXISTING LOW PROFILE PLATFORM (TYP. OF 1 PER SECTOR, TOTAL OF 3)

PROPOSED T-MOBILE RRUS11 B12
MOUNTED TO EXISTING PIPE ON



EXISTING T-MOBILE TWIN AWS TMAS (TYP. OF 1 PER SECTOR, TOTAL OF 3) (TO REMAIN)

EXISTING T-MOBILE AIR21 B2A/B4P ANTENNA (TYP. OF 1 PER SECTOR, TOTAL OF 3) (TO REMAIN)

### **T-MOBILE NORTHEAST LLC**


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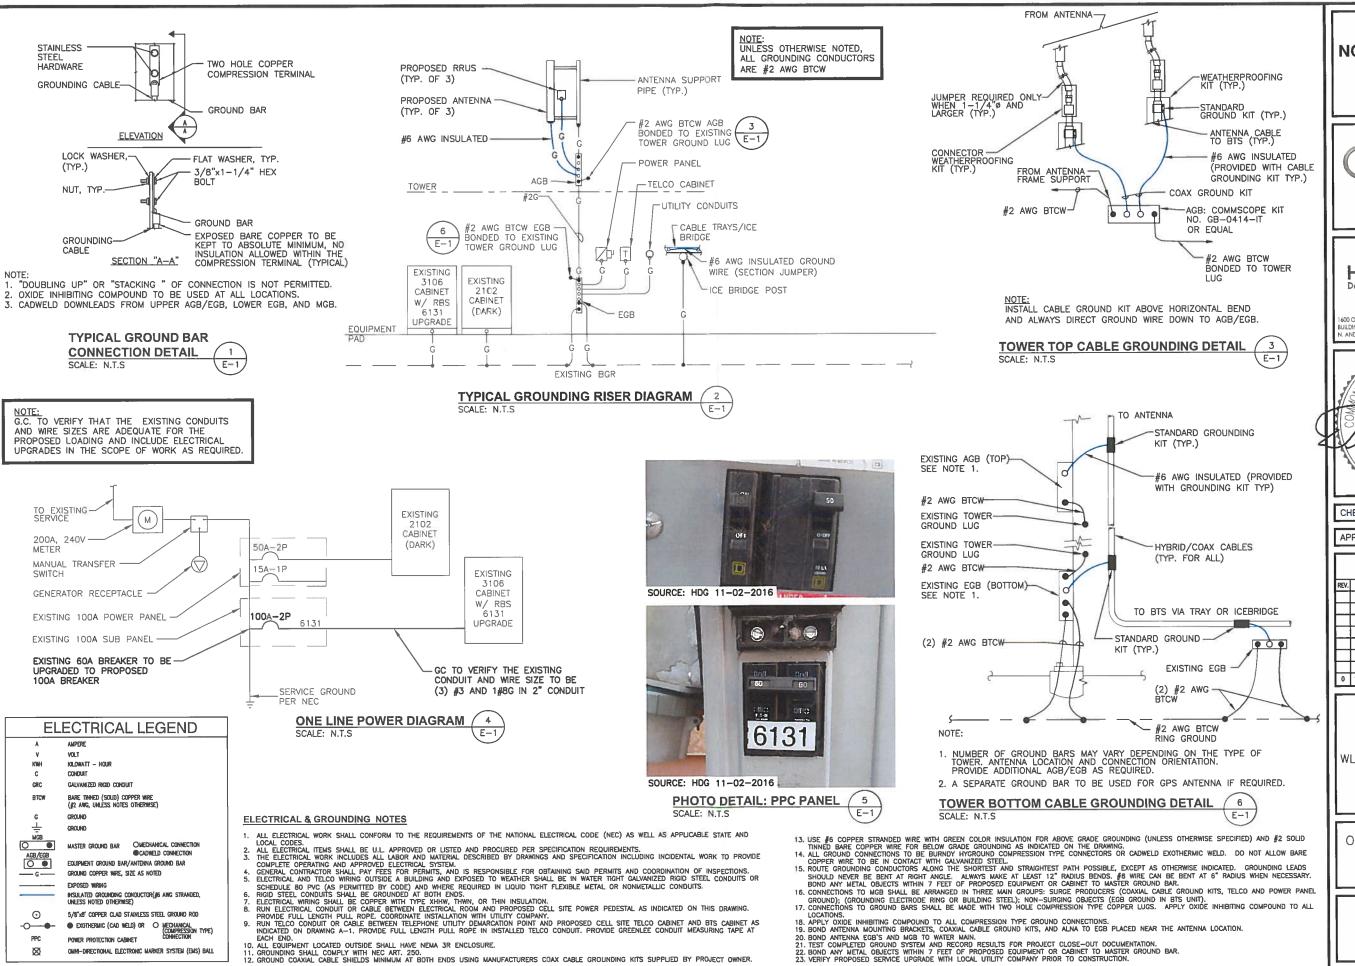
DETAILS

(L700)

SHEET NUMBER

T-MOBILE ELEVATION PHOTO DETAIL SCALE: N.T.S

A-3/

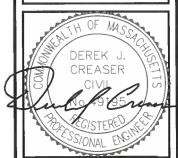

T-MOBILE NORTHEAST LLC

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OD OSGOOD STREET

SUILDING 20 NORTH, SUITE 3090 TEL: (978) 557-555.

N. ANDOVER, MA 01845 FAX: (978) 336-558

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APPROVED BY:

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DJC

**SUBMITTALS** REV. DATE DESCRIPTION 0 11/10/16 ISSUED FOR REVIEW DJM

> 4WL0720A CROWN CASTLE SITE ID: 842903 SITE NAME:

WL720/GRAFTON-AT&T

SITE ADDRESS: 43 ESTABROOK STREET GRAFTON, MA 01519 WORCESTER COUNTY

ONE-LINE DIAGRAM & GROUNDING DETAILS (L700)

SHEET NUMBER